



DEVELOPMENT SERVICES DEPARTMENT
ENVIRONMENTAL COORDINATOR
450 110th Ave NE., P.O. BOX 90012
BELLEVUE, WA 98009-9012

OPTIONAL DETERMINATION OF NON-SIGNIFICANCE (DNS) NOTICE MATERIALS

The attached materials are being sent to you pursuant to the requirements for the Optional DNS Process (WAC 197-11-355). A DNS on the attached proposal is likely. This may be the only opportunity to comment on environmental impacts of the proposal. Mitigation measures from standard codes will apply. Project review may require mitigation regardless of whether an EIS is prepared. A copy of the subsequent threshold determination for this proposal may be obtained upon request.

File No.

Project Name/Address:

Planner:

Minimum Comment Period:

Materials included in this Notice:

Blue Bulletin
Checklist
Vicinity Map
Plans
Other:

OTHERS TO RECEIVE THIS DOCUMENT:

State Department of Fish and Wildlife
State Department of Ecology, Shoreline Planner N.W. Region
Army Corps of Engineers
Attorney General
Muckleshoot Indian Tribe



SEPA Environmental Checklist

The City of Bellevue uses this checklist to help determine whether the environmental impacts of your proposal are significant. This information is also helpful to determine if available avoidance, minimization or compensatory mitigation measures will address the probable significant impacts or if an environmental impact statement will be prepared to further analyze the proposal.

Instructions

The checklist asks you to describe some basic information about your proposal. Please answer each question accurately and carefully and to the best of your knowledge. You may need to consult with an agency specialist or private consultant for some questions.

You may respond with "Not Applicable" or "Does Not Apply" only when you can explain why it does not apply and not when the answer is unknown. You may also attach or incorporate by reference additional studies and reports. Please make complete and accurate answers to these questions to the best of your ability in order to avoid delays. For assistance, see [SEPA Checklist Guidance](#) on the Washington State Department of Ecology website.

The checklist questions apply to all parts of your proposal, even if you plan to do them over a period of time or on different parcels of land. Attach any additional information that will help describe your proposal or its environmental effects. The city may ask you to explain your answers or provide additional information reasonably related to determining if there may be significant adverse impact.

Background

1. Name of proposed project, if applicable _____
2. Name of applicant _____
3. Contact person _____ Phone _____
4. Contact person address _____
5. Date this checklist was prepared _____
6. Agency requesting the checklist _____

7. Proposed timing or schedule (including phasing, if applicable)

8. Do you have any plans for future additions, expansion or further activity related to or connected with this proposal? If yes, explain.

9. List any environmental information you know about that has been prepared or will be prepared, that is directly related to this proposal.

10. Do you know whether applications are pending for governmental approvals of other proposals directly affecting the property covered by your proposal? If yes, explain.

11. List any government approvals or permits that will be needed for your proposal, if known.

Right of Way Permit

12. Give a brief, complete description of your proposal, including the proposed uses and the size of the project and site. There are several questions later in this checklist that ask you to describe certain aspects of your proposal. You do not need to repeat those answers on this page. (Lead agencies may modify this form to include additional specific information on project description.)

See Architectural Plans and Preliminary Landscape Plans. at, 12/29/22

13. Location of the proposal. Give sufficient information for a person to understand the precise location of your proposed project, including a street address, if any, and the section, township and range, if known. If a proposal would occur over a range of area, provide the range or boundaries of the site(s). Provide a legal description, site plan, vicinity map and topographic map, if reasonably available. While you should submit any plans required by the agency, you are not required to duplicate maps or detailed plans submitted with any permit applications related to this checklist.

Environmental Elements

Earth

1. General description of the site:

- ☐ Flat
- ☐ Rolling
- ☐ Hilly
- ☐ Steep Slopes
- ☐ Mountainous
- ☐ Other _____

The site is generally flat with gentle slope down from the north of the project site to the southeast corner. at, 12/29/22

2. What is the steepest slope on the site (approximate percent slope)? _____

3. What general types of soils are found on the site (for example, clay, sand, gravel, peat, muck)? If you know the classification of agricultural soils, specify them and note any agricultural land of long-term commercial significance and whether the proposal results in removing any of these soils.

4. Are there surface indications or history of unstable soils in the immediate vicinity? If so, describe.

5. Describe the purpose, type, total area and approximate quantities and total affected area of any filling, excavation and grading proposed. Indicate the source of the fill.

6. Could erosion occur as a result of clearing, construction or use? If so, generally describe.

See Temporary Erosion Sedimentation Control Plan, prepared by DCI Engineers. at, 12/29/22

7. About what percent of the site will be covered with impervious surfaces after project construction (for example, asphalt or buildings)? _____

8. Proposed measures to reduce or control erosion, or other impacts to the earth, if any.

Project will be required to meet the BCC 23.76.090, Erosion and Sedimentation Control requirements. at, 12/29/22

Air

1. What types of emissions to the air would result from the proposal during construction, operation and maintenance when the project is completed? If any, generally describe and give approximate quantities if known.

2. Are there any off-site sources of emissions or odor that may affect your proposal? If so, generally describe.

3. Proposed measures to reduce or control emissions or other impacts to air, if any.

Construction dust suppression measure per BCC 23.76 will be required. (at, 12/29/22)

Water

1. Surface Water

- a. Is there any surface water body on or in the immediate vicinity of the site (including year-round and seasonal streams, saltwater, lakes, ponds, wetlands)? If yes, describe type and provide names. If appropriate, state what stream or river it flows into.

- b. Will the project require any work over, in or adjacent to (within 200 feet) the described waters? If yes, please describe and attach available plans.

- c. Estimate the amount of fill and dredge material that would be placed in or removed from surface water or wetlands and indicate the area of the site that would be affected. Indicate the source of the fill material.

- d. Will the proposal require surface water withdrawals or diversions? Give a general description, purpose and approximate quantities, if known.

- e. Does the proposal lie within a 100-year floodplain? _____
If so, note the location on the site plan.

- f. Does the proposal involve any discharges of waste materials to surface waters? If so, describe the type of waste and anticipated volume of discharge.

2. Ground Water

- a. Will groundwater be withdrawn from a well for drinking water or other purposes? If so, give a general description of the well, proposed uses and approximate quantities withdrawn from the well. Will water be discharged to groundwater? Give general description, purpose, and approximate quantities if known.

- b. Describe waste material that will be discharged into the ground from septic tanks or other sources, if any (for example: Domestic sewage; industrial, containing the following chemicals...; agricultural; etc.). Describe the general size of the system, the number of such systems, the number of houses to be served (if applicable), or the number of animals or humans the system(s) are expected to serve.

3. Water Runoff (including stormwater)

- a. Describe the source of runoff (including storm water) and method of collection and disposal, if any (include quantities, if known). Where will this water flow? Will this water flow into other waters? If so, describe.

See Preliminary Storm Drainage Report prepared by DCI Engineers for more details. at, 12/29/22

- b. Could waste materials enter ground or surface waters? If so, generally describe.

- c. Does the proposal alter or otherwise affect drainage patterns in the vicinity of the site? If so, describe.

Indicate any proposed measures to reduce or control surface, ground and runoff water, and drainage pattern impacts, if any.

The project will comply with the City of Bellevue Utilities Code 24.06 and Construction Stormwater Pollution Prevention Plan will be required to prevent construction impacts. at, 12/29/22

Plants

1. Check the types of vegetation found on the site:

- ☐ deciduous tree: alder, maple, aspen, other _____
- ☐ evergreen tree: fir, cedar, pine, other _____
- ☐ shrubs
- ☐ grass
- ☐ pasture
- ☐ crop or grain
- ☐ orchards, vineyards or other permanent crops
- ☐ wet soil plants: cattail, buttercup, bulrush, skunk cabbage, other _____
- ☐ water plants: water lily eelgrass, milfoil, other _____
- ☐ other types of vegetation _____

2. What kind and amount of vegetation will be removed or altered?

3. List any threatened and endangered species known to be on or near the site.

4. Proposed landscaping, use of native plants or other measures to preserve or enhance vegetation on the site, if any.

Street trees will be provided along 103rd Ave. NE and Main Street, per City of Bellevue Transportation standards. at, 12/29/22

5. List all noxious weeds and invasive species known to be on or near the site.

Animals

1. List any birds and other animals which have been observed on or near the site or are known to be on or near the site. Examples include:

Birds: ☐hawk, ☐heron, ☐eagle, ☐songbirds, ☐other _____

Mammals: ☐deer, ☐bear, ☐elk, ☐beaver, ☐other _____

Fish: ☐bass, ☐salmon, ☐trout, ☐herring, ☐shellfish, ☐other _____

2. List any threatened and endangered species known to be on or near the site.

3. Is the site part of a migration route? If so, explain.

X

Yes, the site is part of the Pacific Flyway, one of the principal north-south migration routes for birds, including the Canadian geese, herons and other migratory birds in North America.
AT, 12/29/22

4. Proposed measures to preserve or enhance wildlife, if any.

5. List any invasive animal species known to be on or near the site.

Invasive species known to be present in King County include European Starling, House Sparrow and Eastern Gray Squirrel. AT, 12/29/22

Energy and Natural Resources

1. What kinds of energy (electric, natural gas, oil, wood stove, solar) will be used to meet the completed project's energy needs? Describe whether it will be used for heating, manufacturing, etc.

2. Would your project affect the potential use of solar energy by adjacent properties? If so, generally describe.

This project will be 4 to 5 stories taller than the adjacent buildings to the west and may affect solar access for PV panels on those existing buildings. The project will not affect the potential use of solar energy by properties to the north, south and east. at, 12/29/22

3. What kinds of energy conservation features are included in the plans of this proposal? List other proposed measures to reduce or control energy impacts, if any.

The project will be required to meet the applicable Washington State Energy Code and City of Bellevue Energy Code at time of construction permit review. AT, 12/29/22

Environmental Health

1. Are there any environmental health hazards, including exposure to toxic chemicals, risk of fire and explosion, spill or hazardous waste, that could occur as a result of this proposal? If so, describe.

- a. Describe any known or possible contamination at the site from present or past uses.

- b. Describe existing hazardous chemicals/conditions that might affect project development and design. This includes underground hazardous liquid and gas transmission pipelines located within the project area and in the vicinity.

- c. Describe any toxic or hazardous chemicals that might be stored, used, or produced during the project's development or construction, or at any time during the operating life of the project.

- d. Describe special emergency services that might be required.

- e. Proposed measures to reduce or control environmental health hazards, if any.

2. Noise

- a. What types of noise exist in the area which may affect your project (for example: traffic, equipment, operation, other)?

- b. What types and levels of noise would be created by or associated with the project on a short-term or a long-term basis (for example: traffic, construction, operation, other)?
Indicate what hours noise would come from the site.

- c. Proposed measures to reduce or control noise impacts, if any.

The project will comply with City of Bellevue Noise Ordinance, BMC 9.18. at, 12/29/22

Land and Shoreline Uses

1. What is the current use of the site and adjacent properties? Will the proposal affect current land uses on nearby or adjacent properties? If so, describe.

2. Has the project site been used as working farmlands or working forest lands? If so, describe. How much agricultural or forest land of long-term commercial significance will be converted to other uses as a result of the proposal, if any? If resource lands have not been designated, how many acres in farmland or forest land tax status will be converted to non-farm or non-forest use?

- a. Will the proposal affect or be affected by surrounding working farm or forest land normal business operations, such as oversize equipment access, the application of pesticides, tilling and harvesting? If so, how?

3. Describe any structures on the site.

4. Will any structures be demolished? If so, what?

5. What is the current zoning classification of the site? _____

6. What is the current comprehensive plan designation of the site? _____ Downtown, at, 12/29/22

7. If applicable, what is the current shoreline master program designation of the site?

8. Has any part of the site been classified as a critical area by the city or county? If so, specify.

9. Approximately how many people would reside or work in the completed project? _____

10. Approximately how many people would the completed project displace? _____

11. Proposed measures to avoid or reduce displacement impacts, if any.

12. Proposed measures to ensure the proposal is compatible with existing and projected land uses and plans, if any.

13. Proposed measures to ensure the proposal is compatible with nearby agricultural and forest lands of long-term commercial significance, if any.

Housing

1. Approximately how many units would be provided, if any? Indicate whether high, middle, or low-income housing.

2. Approximately how many units, if any, would be eliminated? Indicate whether high, middle, or low-income housing.

3. Proposed measures to reduce or control housing impacts, if any.

Aesthetics

1. What is the tallest height of any proposed structure(s), not including antennas; what is the principal exterior building material(s) proposed?

2. What views in the immediate vicinity would be altered or obstructed?

3. Proposed measures to reduce or control aesthetic impacts, if any

The project shall comply with the applicable Downtown Development standards (LUC 20.25A). (AT, 12/29/22)

Light and Glare

1. What type of light or glare will the proposal produce? What time of day would it mainly occur?

2. Could light or glare from the finished project be a safety hazard or interfere with views?

3. What existing off-site sources of light or glare may affect your proposal?

4. Proposed measures to reduce or control light and glare impacts, if any.

The project shall comply with the City of Bellevue standards, LUC 20.20.522, Light and Glare. AT, 12/29/22

Recreation

1. What designated and informal recreational opportunities are in the immediate vicinity?

2. Would the proposed project displace any existing recreational uses? If so, describe.

3. Proposed measures to reduce or control impacts on recreation, including recreation opportunities to be provided by the project or applicant, if any.

Historic and Cultural Preservation

1. Are there any buildings, structures or sites located on or near the site that are over 45 years old listed in or eligible for listing in national, state or local preservation registers located on or near the site? If so, specifically describe.

2. Are there any landmarks, features or other evidence of Indian or historic use or occupation? This may include human burials or old cemeteries. Are there any material evidence, artifacts or areas of cultural importance on or near the site? Please list any professional studies conducted at the site to identify such resources.

3. Describe the methods used to assess the potential impacts to cultural and historic resources on or near the project site. Examples include consultation with tribes and the department of archeology and historic preservation, archaeological surveys, historic maps, GIS data, etc.

4. Proposed measures to avoid, minimize or compensate for loss, changes to and disturbance to resources. Please include plans for the above and any permits that may be required.

Transportation

1. Identify public streets and highways serving the site or affected geographic area and describe proposed access to the existing street system. Show on site plans, if any.

2. Is the site or affected geographic area currently served by public transit? If so, generally describe. If not, what is the approximate distance to the nearest transit stop?

3. How many additional parking spaces would the completed project or non-project proposal have? How many would the project or proposal eliminate?

4. Will the proposal require any new or improvements to existing roads, streets, pedestrian, bicycle or state transportation facilities, not including driveways? If so, generally describe (indicate whether public or private).

5. Will the project or proposal use (or occur in the immediate vicinity of) water, rail or air transportation? If so, generally describe.

6. How many vehicular trips per day would be generated by the completed project or proposal? If known, indicate when peak volumes would occur and what percentage of the volume would be trucks (such as commercial and non-passenger vehicles). What data or transportation models were used to make these estimates?

7. Will the proposal interfere with, affect or be affected by the movement of agricultural and forest products on roads or streets in the area? If so, generally describe.

8. Proposed measures to reduce or control transportation impacts, if any.

See Traffic Impact Analysis Report dated 12/14/22 and Traffic Study dated 12/12/22 by TENW. at, 12/29/22

Public Service

1. Would the project result in an increased need for public services (for example: fire protection, police protection, public transit, health care, schools, other)? If so, generally describe.

2. Proposed measures to reduce or control direct impacts on public services, if any.

With addition of new residents of this project to the BelRed neighborhood, new school facilities may be needed in the future. at, 12/29/22

Utilities

1. Check the utilities currently available at the site:

- ☐ Electricity
- ☐ natural gas
- ☐ water
- ☐ refuse service
- ☐ telephone
- ☐ sanitary sewer
- ☐ septic system
- ☐ other

2. Describe the utilities that are proposed for the project, the utility providing the service and the general construction activities on the site or in the immediate vicinity which might be needed.

Signature

The above answers are true and complete to the best of my knowledge. I understand that the lead agency is relying on them to make its decision.

Signature Wally Burt


Name of signee _____

Position and Agency/Organization _____

Date Submitted _____

City of Bellevue Review by: Amy Tarce, 12/29/22

22-130414-LD North of Main
SITE PLAN

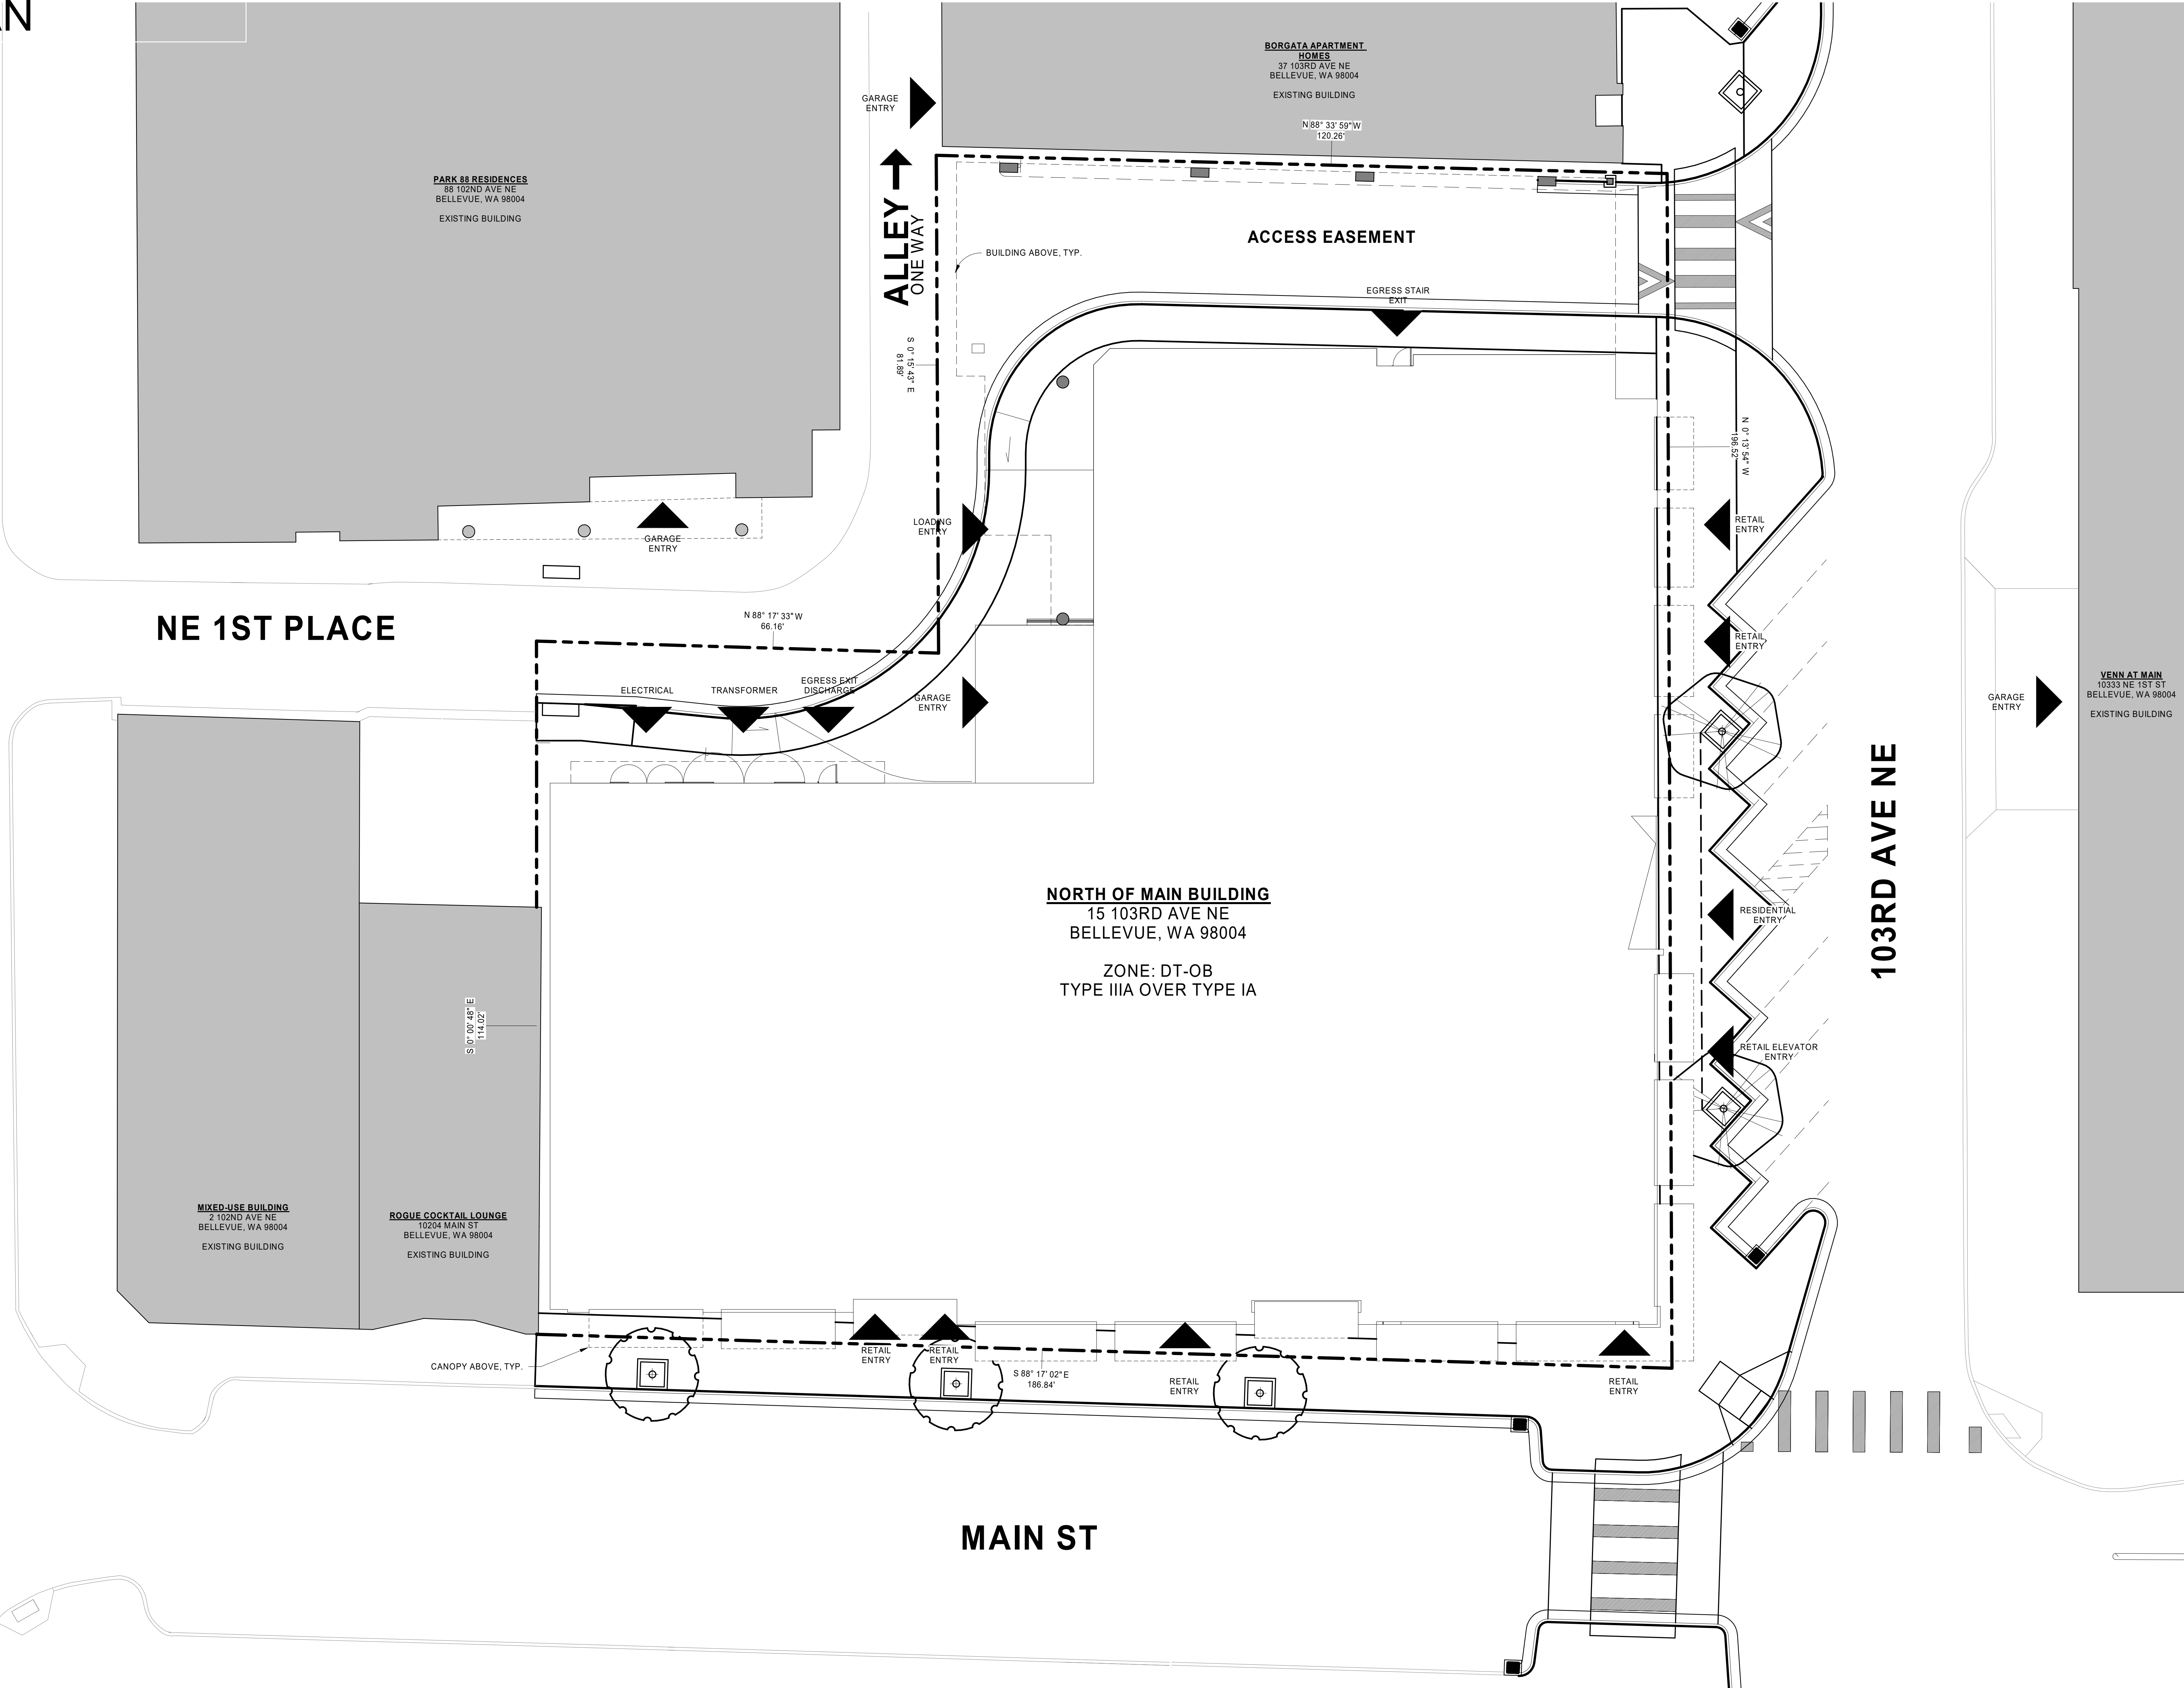

1 SITE PLAN
SCALE: 3/32" = 1'-0"

WEBER
THOMPSON

900 N 34th Street, Suite 200
Seattle, WA 98103
206.344.5700

Project:

NORTH OF MAIN

15 103RD AVE NE
BELLEVUE, WA 98004

Client:

VANDER HOEK
CORPORATION

10220 NE 1ST PLACE,
SUITE 202
BELLEVUE, WA 98004

Issue:

50% SD
100% SD
DESIGN REVIEW (LD)

06/23/2022
11/16/2022
11/13/2022

Construction Revision:

9785
REGISTERED
ARCHITECT
JEFFREY T. REIDMAN
STATE OF WASHINGTON

Phase:	Client Approval:	Quality Assurance:
Schematics	_____	_____
Design Dev.	_____	_____
Permit Doc.	_____	_____
Int. Doc.	_____	_____
Const. Doc.	_____	_____

Drawn By: SET
Project Manager: LKB
Principal In Charge: JR

NOT FOR CONSTRUCTION
DESIGN REVIEW (LD)

SITE PLAN

A1.00

Project Number: 21-020

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NORTH OF MAIN

15 103RD AVE NE
BELLEVUE, WA 98004

DESIGN REVIEW SUBMITTAL



BIRDEYE PERSPECTIVE

PERMIT NUMBERS

22-113953-DB PRE-APPLICATION DB
1242126 BOUNDARY LINE ADJUSTMENT
XXXXXX LAND USE
XXXXXX CONSTRUCTION
XXXXXX SHORING AND EXCAVATION
XXXXXX FOUNDATION AND STRUCTURE TO GRADE

PERMIT SUBMITTALS

PERMIT PACKAGES:
ARCHITECTURAL
STRUCTURAL

DEFERRED SUBMITTALS:
GUARDRAILS
PREFABRICATED STAIRS
SIGNAGE

SUBMITTALS UNDER SEPARATE PERMIT:
FIRE PROTECTION
ALARM AND SIGNALING
PLUMBING
ELECTRICAL
STREET IMPROVEMENTS

PROJECT TEAM

OWNER	ARCHITECT / APPLICANT	LANDSCAPE ARCHITECT
VANDER HOEK CORPORATION 10220 NE 1ST PLACE, SUITE 202 BELLEVUE, WA 98004 TEL: 425-681-0842 CONTACT: CARL VANDER HOEK EMAIL: CARL@CLEVERLYDEVELOPMENT.COM	WEBER THOMPSON 900 N 34TH STREET, SUITE 200 SEATTLE, WA 98103 TEL: 206-344-5700 CONTACT: EMAIL:	WEBER THOMPSON 900 N 34TH STREET, SUITE 200 SEATTLE, WA 98103 TEL: 206-344-5700 CONTACT: EMAIL:
INTERIOR DESIGN	STRUCTURAL ENGINEER	CIVIL ENGINEER
ADDRESS ADDRESS CITY, STATE ZIP CODE TEL: CONTACT: EMAIL:	COUGHLIN PORTER LUNDEEN 801 SECOND AVE., SUITE 900 SEATTLE, WA 98104 TEL: 206-343-0480 CONTACT: BEN BARLOW EMAIL: BENB@CPLINC.COM	DCI ENGINEERS 818 STEWART STREET, SUITE 1000 SEATTLE, WA 98101 TEL: 206-332-1900 CONTACT: MATTHEW FRISBY EMAIL: MFRISBY@DCI-ENGINEERS.COM
PERMIT CONSULTANT	SURVEYOR	ACOUSTICAL CONSULTANT
ADDRESS ADDRESS CITY, STATE ZIP CODE TEL: CONTACT: EMAIL:	BUSH, ROED & HITCHINGS, INC. ADDRESS CITY, STATE ZIP CODE TEL: CONTACT: EMAIL:	ADDRESS ADDRESS CITY, STATE ZIP CODE TEL: CONTACT: EMAIL:
CONTRACTOR	LEED CONSULTANT	MEP DESIGN DEVELOPMENT
W.G. CLARK CONSTRUCTION CO. 1945 YALE PL E SEATTLE, WA 98102 TEL: 206-340-6857 CONTACT: RICK WORKMAN EMAIL: RWORKMAN@WGCLARK.COM	RUSHING 1725 WESTLAKE AVE N SUITE 300 SEATTLE, WA 98109 TEL: 206-258-7100 CONTACT: STEFANIE YOUNG EMAIL: RUSHING-NORTHOFMAIN@RUSHINGCO.COM	RUSHING 1725 WESTLAKE AVE N SUITE 300 SEATTLE, WA 98109 TEL: 206-258-7100 CONTACT: REED RUSHING EMAIL: RUSHING-NORTHOFMAIN@RUSHINGCO.COM
SHORING	MECHANICAL/PLUMBING DESIGN BUILD	ELECTRICAL DESIGN BUILD
GROUND SUPPORT 16932 WOODINVILLE REDMOND ROAD NE, SUITE 210 WOODINVILLE, WA 98072 TEL: 425-885-9338 CONTACT: JOHN BYRNE EMAIL: JOHNB@GROUNDSUPPORT.COM	ADDRESS ADDRESS CITY, STATE ZIP CODE TEL: CONTACT: EMAIL:	ADDRESS ADDRESS CITY, STATE ZIP CODE TEL: CONTACT: EMAIL:
GEOTECH	VERTICAL TRANSPORTATION	BUILDING ENVELOPE
PBS 4412 S CORBETT AVENUE PORTLAND, OR 97259 TEL: 503-248-1939 CONTACT: SPENCER AMBAUEN EMAIL: SPENCER.AMBAUEN@PBSUSA.COM	ADDRESS ADDRESS CITY, STATE ZIP CODE TEL: CONTACT: EMAIL:	ADDRESS ADDRESS CITY, STATE ZIP CODE TEL: CONTACT: EMAIL:
ACCESSIBILITY		
ADDRESS ADDRESS CITY, STATE ZIP CODE TEL: CONTACT: EMAIL:		

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THOMPSON

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206.344.5700

Project:

NORTH OF MAIN

15 103RD AVE NE
BELLEVUE, WA 98004

Client:

**VANDER HOEK
CORPORATION**


10220 NE 1ST PLACE,
SUITE 202
BELLEVUE, WA 98004

Issue:

50% SD 06/23/2022
100% SD 11/16/2022
DESIGN REVIEW (LD) 11/13/2022

Construction Revision:

22-130414-LD North of Main Mixed Use Building

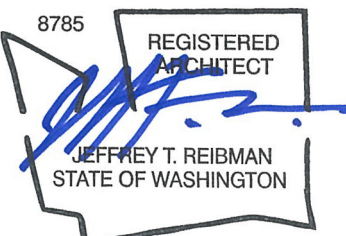

Phase	Client Approval	Quality Assurance
Schematics	_____	_____
Design Dev.	_____	_____
Permit Doc.	_____	_____
Ref Doc.	_____	_____
Const Doc.	_____	_____
Drawn By:		SET
Project Manager:		LKB
Principal In Charge:		JR

COVER SHEET

G0.00

Project Number: 21-020
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2 NORTH ELEVATION COLOR
SCALE: 1/8" = 1'-0"



3 EAST ELEVATION COLOR
SCALE: 1/8" = 1'-0"

MATERIAL LEGEND

- 1 CLEAR VISION GLASS
- 2 METAL STOREFRONT SYSTEM
- 3 METAL LOUVRES
- 4A VINYL WINDOW BLACK
- 4B VINYL WINDOW WHITE
- 4C VINYL WINDOW BROWN
- 5 BRICK
- 6A CONCRETE CAST-IN-PLACE
- 6B CONCRETE ARCHITECTURAL FINISH CONCRETE
- 7 CEMENTITIOUS ACCENT PANEL
- 8A FIBER CEMENT PANEL - LIGHT
- 8B FIBER CEMENT PANEL - DARK
- 8C FIBER CEMENT LAP - LIGHT
- 9A METAL (7) CORNICE - LIGHT
- 9B METAL (7) CORNICE - DARK
- 10A DOOR FRAME - DARK
- 10B DOOR FRAME - LIGHT
- 11 METAL + GLASS BALCONY
- 12 METAL + GLASS CANOPY
- 13 WOOD-LOOK ACCENT PANEL

COLORED ELEVATION NOTES

1. COLORED ELEVATIONS ARE PROVIDED FOR REFERENCE TO HELP CLARIFY MATERIAL TRANSITIONS. SEE PRIMARY ELEVATION SHEETS A3.01-A3.02 FOR DETAILED INFORMATION AND REQUIREMENTS NOT SHOWN.

WEBER
THOMPSON

900 N 34th Street, Suite 200
Seattle, WA 98103
206.344.5700

Project:

NORTH OF MAIN

15 103RD AVE NE
BELLEVUE, WA 98004

Client:

**VANDER HOEK
CORPORATION**


10220 NE 1ST PLACE,
SUITE 202
BELLEVUE, WA 98004

Issue:

DESIGN REVIEW (LD) 11/13/2022

Construction Revision:

22-130414-LD North of Main Mixed Use Building

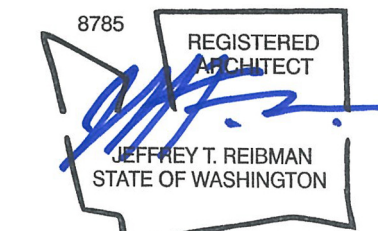

Phase	Client Approval	Quality Assurance
Schematic		
Design Dev.		
Permit Doc.		
Rev. Doc.		
Const. Doc.		

Drawn By: SET
Project Manager: LKB
Principal In Charge: JR

**BUILDING ELEVATIONS
(COLORED)**

A3.10

Project Number: 21-020

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DESIGN REVIEW (LD)

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1 SOUTH ELEVATION COLOR
SCALE: 1/8" = 1'-0"



2 WEST ELEVATION COLOR
SCALE: 1/8" = 1'-0"

MATERIAL LEGEND

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- 9A METAL (7) CORNICE - LIGHT
- 9B METAL (7) CORNICE - DARK
- 10A DOOR FRAME - DARK
- 10B DOOR FRAME - LIGHT
- 11 METAL + GLASS BALCONY
- 12 METAL + GLASS CANOPY
- 13 WOOD-LOOK ACCENT PANEL

COLORED ELEVATION NOTES

- COLORED ELEVATIONS ARE PROVIDED FOR REFERENCE TO HELP CLARIFY MATERIAL TRANSITIONS. SEE PRIMARY ELEVATION SHEETS A3.01-A3.02 FOR DETAILED INFORMATION AND REQUIREMENTS NOT SHOWN.

WEBER
THOMPSON

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Project:

NORTH OF MAIN

15 103RD AVE NE
BELLEVUE, WA 98004

Client:

**VANDER HOEK
CORPORATION**

10220 NE 1ST PLACE,
SUITE 202
BELLEVUE, WA 98004

Issue:

DESIGN REVIEW (LD)

11/13/2022

Construction Revision:

22-130414-LD North of Main Mixed Use Building



Phase	Client Approval	Quality Assurance
Schematic		
Design Dev.		
Permit Doc.		
Rev. Doc.		
Const. Doc.		

Drawn By: SET
Project Manager: LKB
Principal In Charge: JR

**BUILDING ELEVATIONS
(COLORED)**

A3.11

Project Number: 21-020

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